# IMPROVEMENT PLANS FOR

UNLV/EPA PARKING LOT


@HARMON AVE.


APN: 162-22-601-001

# OWNER/DEVELOPER

UNIVERSITY BOARD OF REGENTS

CONTACT: TIM LOCKETT
DIRECTOR OF CONSTRUCTION
UNIVERSITY OF NEVADA LAS VEGAS
4505 S. MARYLAND PARKWAY
PO BOX 451027
LAS VEGAS, NV 89154-1027

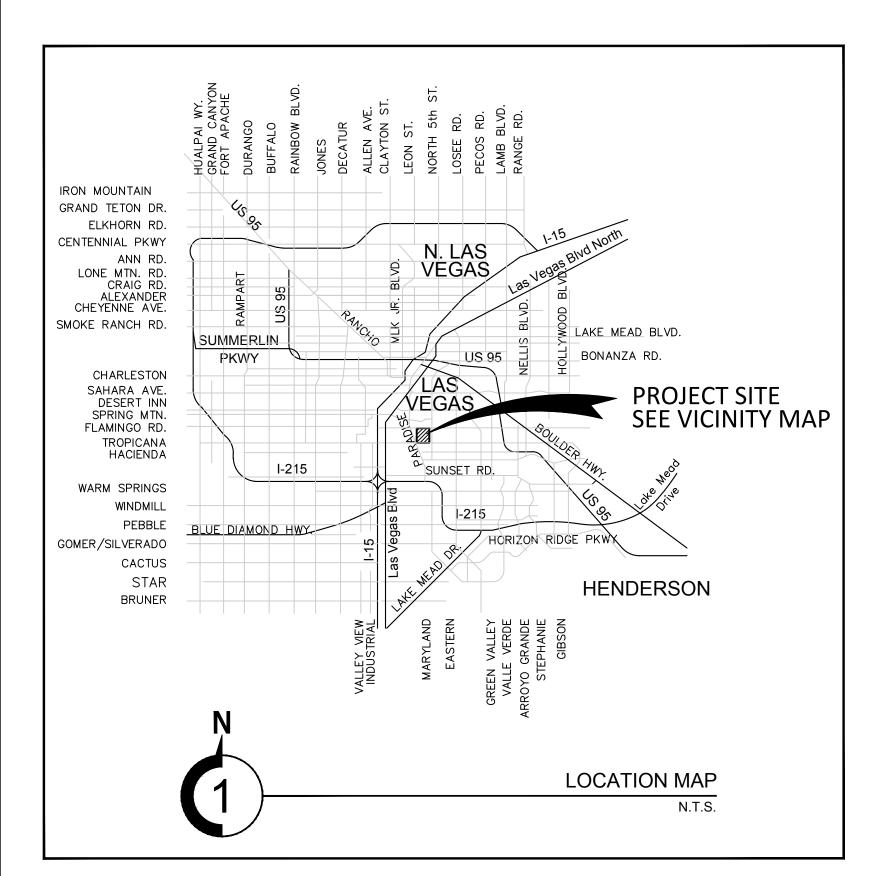

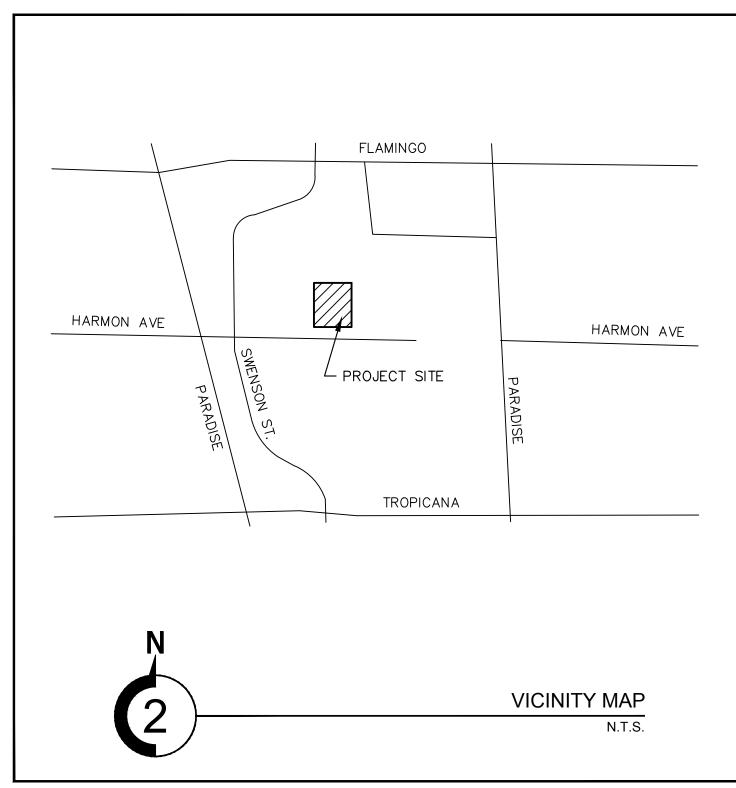

# FLOOD ZONE NOTE:

FLOODPLAIN.

AS SHOWN BY FLOOD INSURANCE RATE MAP NO. 32003C2557F, DATED NOVEMBER 16, 2011, AN UNSHADED ZONE X, AREA DETERMINED TO BE OUTSIDE THE 0.2% ANNUAL CHANCE

# BASIS OF BEARING

NORTH 00°05'46" EAST, BEING THE BEARING OF THE EAST LINE OF THE SOUTHWEST QUARTER (SW 1/4) OF SECTION 22, TOWNSHIP 22 SOUTH, RANGE 61 EAST, M.D.M., CLARK COUNTY, NEVADA, AS SHOWN IN FILE 65 OF SURVEYS, AT PAGE 69, OFFICIAL RECORDS OF CLARK COUNTY, NEVADA.

# **BENCHMARK**

CLARK COUNTY VERTICAL CONTROL V.2003 POINT "6C11 23NWW6", BEING A RIVET AND SQUARE ALUMINUM PLATE IN THE TOP OF CURB, NORTHEAST CORNER OF MARYLAND PARKWAY AND ROCHELLE AVENUE NEAR THE PC OF MARYLAND PARKWAY.

ELEVATION: 2009.29 (US SURVEY FEET)

CLARK COUNTY VERTICAL CONTROL V.2003 BASED ON NORTH AMERICAN VERTICAL DATUM OF 1988 (NAVD 88).

# APPROVALS

NV ENERGY ACKNOWLEDGES THAT WE HAVE RECEIVED YOUR PLANS AND WILL PROVIDE SERVICE TO ALL ELECTRICAL NEEDS ASSOCIATED WITH THIS PROJECT. NV ENERGY RESERVES THE RIGHT TO ADDRESS ANY EXISTING OR FUTURE CONFLICTS ONCE THE FINAL DESIGN IS COMPLETED. THE NEW SERVICE AND THE RESOLUTION OF ANY CONFLICTS WILL BE ACCOMPLISHED PURSUANT TO THE NEVADA PUBLIC UTILITY COMMISSION'S RULES AND REGULATIONS.

NV ENERGY

"THE AFFIXED CENTURY LINK APPROVAL DOES NOT ASSUME OR GUARANTEE LIABILITY FOR KNOWN OR UNKNOWN CONFLICTS WITH EXISTING OR PROPOSED IMPROVEMENTS. RESOLUTION OF ANY CONFLICT WILL BE ACCOMPLISHED PURSUANT TO LOCAL ORDINANCES, NEVADA REVISED STATUTES AND/OR PUBLIC UTILITY COMMISSION RULES AND REGULATIONS."

CENTRAL TELEPHONE COMPANY DBA CENTURY LINK

SOUTHWEST GAS CORPORATION DATE

COUNTY OF CLARK FIRE DEPARTMENT APPROVAL

APPROVAL OF THESE PLANS SHALL NOT BE CONSTRUED TO BE A PERMIT FOR, OR AN APPROVAL OF, ANY VIOLATION OF ANY OF THE PROVISIONS OF THE STATE OR COUNTY LAWS.

FIRE FLOW \_\_\_\_\_ GPM AT 20 PSI RESIDUAL

COX COMMUNICATIONS LAS VEGAS, INC.

"THE CONTRACTOR WILL CONTACT THE NEVADA DIVISION OF ENVIRONMENTAL PROTECTION (NDEP) TO OBTAIN A NATIONAL POLLUTANT DISCHARGE ELIMINATION SYSTEM (NPDES) PERMIT PRIOR TO CONSTRUCTION. ALL CONSTRUCTION PROJECTS ONE ACRE OR LARGER MUST APPLY FOR A PERMIT THROUGH NDEP. ALL QUESTIONS REGARDING THE NPDES PERMIT REQUIREMENTS SHOULD BE DIRECTED TO THE NDEP AT (775) 687-9429."

LTERNATE BID

UNLV/EPA PARKING LOT

	DESCRIPTION					
	DESIGN BY					
	DATE					
	NO.					
CEI PROJECT:			:	9937		
DE	SIGN	BY:		T	QТ	
DR	AWN I	3Y:		TQT/SS		
СН	ECKED	BY	:	T	ДT	
		DAT				

12/21/2016

SCALE:

N.T.S.

SHEET NUMBER

SHEET 01 OF 08

**INDEX OF DRAWINGS** 

SHEET NO.

1. C1.01

2. C1.02

3. C1.03

4. C2.01

5. C3.01

6. C4.01

7. C6.01

SHEET TITLE

GENERAL NOTES

OVERALL SITE PLAN

DEMOLITION PLAN

GRADING PLAN

DETAIL SHEET

COVER AND APPROVAL SHEET

HORIZONTAL CONTROL PLAN

SIGNAGE AND STRIPING PLAN

# **GENERAL NOTES**

- CONTRACTOR SHALL PROVIDE ALL NECESSARY HORIZONTAL AND VERTICAL TRANSITIONS BETWEEN NEW CONSTRUCTION AND EXISTING SURFACES TO PROVIDE FOR PROPER DRAINAGE AND INGRESS AND EGRESS TO SAID CONSTRUCTION. EXTENT OF TRANSITIONS TO BE DETERMINED BY THE COUNTY ENGINEER.
- THE ENGINEER DOES NOT ASSUME ANY RESPONSIBILITY FOR UTILITIES OR STRUCTURES NOT IN THE LOCATION SHOWN PRIOR TO START OF CONSTRUCTION. IT IS THE CONTRACTOR'S RESPONSIBILITY TO VERIFY ALL UNDERGROUND UTILITIES PRIOR TO CONSTRUCTION. THE CONTRACTOR SHALL USE EXTREME CAUTION WHEN WORKING OVER OR NEAR EXISTING GAS MAINS AND UNDERGROUND POWER LINES.
- 48 HOURS PRIOR TO START OF CONSTRUCTION THE CONTRACTOR SHALL CONTACT: LAS VEGAS VALLEY WATER DISTRICT 870-2011 367-5001 NV FNFRGY CENTURY LINK 244-7171 SOUTHWEST GAS CORPORATION 651-2111

COX COMMUNICATIONS (CABLE CO.)

- THE CONTRACTOR SHALL TAKE ALL PRECAUTIONARY MEASURES NECESSARY TO PROTECT EXISTING IMPROVEMENTS, WHICH ARE TO REMAIN IN PLACE FROM DAMAGE AND ALL SUCH IMPROVEMENTS OR STRUCTURES DAMAGED BY THE CONTRACTOR'S OPERATIONS SHALL BE REPAIRED OR RECONSTRUCTED SATISFACTORY TO THE ENGINEER AT THE EXPENSE OF THE CONTRACTOR.
- ALL BARRICADING AND TEMPORARY TRAFFIC CONTROL DEVICES OR METHODS USED DURING CONSTRUCTION SHALL BE IN ACCORDANCE WITH THE MUTCD EXCEPT AS OTHERWISE PROVIDED IN THE CONTRACT SPECIFICATIONS OR REQUIRED BY THE ENGINEER.

384-8084

- THE QUANTITIES GIVEN IN THE DRAWINGS ARE APPROXIMATE ONLY, BEING GIVEN AS A BASIS FOR THE COMPARISON OF BIDS, AND THE OWNER DOES NOT EXPRESSLY OR BY IMPLICATION, AGREE THAT THE ACTUAL AMOUNT OF WORK WILL CORRESPOND THEREWITH, BUT RESERVES THE RIGHT TO MAKE SUCH ALTERATIONS, DEVIATIONS, ADDITIONS TO OR OMISSIONS FROM THE PLANS AND SPECIFICATIONS, INCLUDING THE RIGHT TO INCREASE OR DECREASE THE QUANTITY OF ANY ITEM OR PORTION OF THE WORK, AS MAY BE DEEMED BY THE OWNER TO BE NECESSARY. ANY SUCH CHANGES WILL BE SET FORTH IN A CONTRACT CHANGE ORDER WHICH WILL SPECIFY, IN ADDITION TO THE WORK TO BE DONE IN CONNECTION WITH THE CHANGE MADE, ADJUSTMENT OF CONTRACT TIME, IF ANY, AND THE BASIS OF COMPENSATION FOR SUCH WORK. A CONTRACT CHANGE ORDER WILL NOT BECOME EFFECTIVE UNTIL APPROVED BY THE OWNER.
- THE CONTRACTOR SHALL BE RESPONSIBLE FOR THE VERTICAL ADJUSTMENT OF ALL EXISTING SANITARY, WATER AND STORM SEWER MANHOLES TO THE FINAL FINISH GRADES IN ACCORDANCE WITH SECTION 609 OF THE STANDARD SPECIFICATIONS.
- REMOVAL OR RELOCATION OF POWER POLES, TELEPHONE POLES, JOINTLY-OWNED POLES AND APPURTENANCES WHICH INTERFERE WITH IMPROVEMENTS REQUIRED TO BE CONSTRUCTED UNDER THIS CONTRACT, SHALL BE THE RESPONSIBILITY OF CONTRACTOR.
- THE CONTRACTOR SHALL BE RESPONSIBLE FOR THE VERTICAL ADJUSTMENT OF ALL TELEPHONE COMPANY MANHOLES TO THE FINAL FINISH GRADES AS SHOWN ON THE CONTRACT DRAWINGS.
- 10. ALL CONCRETE FOR THIS PROJECT SHALL USE TYPE V CEMENT.
- SLOPES STEEPER THAN 4:1 AND FINE-GRAINED MATERIALS THAT HAVE BEEN DISTURBED (SANDY AND SILTY MATERIALS), SHOULD BE PROTECTED WITH BURLAP AND OTHER EROSION CONTROL FABRIC/MATERIAL, UNLESS OTHERWISE SPECIFIED BY THE LANDSCAPE DRAWINGS AND SPECIFICATIONS, OR THE SOILS REPORT.
- CONTRACTOR SHALL NOTIFY THE ENGINEER WITHIN 24 HOURS OF OMISSIONS AND ERRORS DISCOVERED ON PLANS. THE ENGINEERING WILL REVISE AND RE-ISSUE DRAWINGS AS SOON AS POSSIBLE. THE ENGINEER WILL NOT BE RESPONSIBLE FOR ANY "CORRECTIVE" WORK DONE BY OTHERS.

# TRAFFIC NOTES

- 1. ALL PERMANENT TRAFFIC CONTROL DEVICES CALLED FOR HEREON SHALL BE IN PLACE AND IN FINAL POSITION PRIOR TO ALLOWING ANY PUBLIC TRAFFIC ONTO THE PORTIONS OF THE ROAD(S) BEING IMPROVED HEREUNDER, REGARDLESS OF THE STATUS OF COMPLETION OF PAVING OR OTHER OFF-SITE IMPROVEMENTS CALLED FOR BY THESE PLANS.
- 2. BEFORE ANY WORK IS STARTED IN THE RIGHT-OF-WAY, THE CONTRACTOR SHALL INSTALL ALL ADVANCE WARNING SIGNS FOR THE CONSTRUCTION ZONE. THE CONTRACTOR SHALL INSTALL TEMPORARY GROUND MOUNTED STOP SIGNS AT ALL NEW STREET ENCROACHMENTS INTO EXISTING COUNTY STREETS IMMEDIATELY AFTER FIRST GRADING WORK IS ACCOMPLISHED AND SHALL MAINTAIN SAID SIGNS UNTIL PERMANENT SIGNS ARE INSTALLED.
- 3. ALL CONSTRUCTION SIGNING, BARRICADING AND PAVEMENT MARKINGS SHALL CONFORM TO THE NEVADA WORK ZONE TRAFFIC CONTROL HANDBOOK - 1986 AND TO THE MANUAL ON UNIFORM TRAFFIC CONTROL DEVICES, CURRENT EDITION.
- 4. IF THE IMPROVEMENTS NECESSITATE THE OBLITERATION, TEMPORARY OBSTRUCTION, TEMPORARY REMOVAL OR RELOCATION OF ANY EXISTING TRAFFIC PAVEMENT MARKING, SUCH PAVEMENT MARKING SHALL BE RESTORED OR REPLACED WITH LIKE MATERIALS.
- 5. THE DEVELOPER SHALL BE RESPONSIBLE TO PROVIDE AND INSTALL ALL PERMANENT SIGNS SHOWN ON THE PLANS. STREET NAME SIGNS SHALL CONFORM IN THEIR ENTIRETY TO CLARK COUNTY AREA STANDARDS. ALL OTHER SIGNS SHALL BE STANDARD SIZE UNLESS OTHERWISE SPECIFIED ON THE PLANS.
- 6. IF A PROPOSED STREET LIGHT STANDARD IS FIELD LOCATED TO WITHIN FIVE (5) FEET OF ANY SIGN SHOWN HEREON TO BE MOUNTED ON A SIGN POST, CHANGE SIGN MOUNTING TO ONE ON THE STREETLIGHT STANDARD.
- 7. PRIOR TO CONSTRUCTION, THE STREET SIGN CONTRACTOR SHALL OBTAIN STREET NAMES AND BLOCK NUMBERING FROM THE CURRENT PLANNING DIVISION OF THE DEPARTMENT OF
- 8. ALL TRAFFIC SIGNAL POLE ASSEMBLIES, STEEL PEDESTAL FOR CABINETS AND STREET LIGHT POLES SHALL BE GALVANIZED PER ASTM a.123.

# BASIS OF BEARING

NORTH 00°05'46" EAST. BEING THE BEARING OF THE EAST LINE OF THE SOUTHWEST QUARTER (SW 1/4) OF SECTION 22, TOWNSHIP 22 SOUTH, RANGE 61 EAST, M.D.M., CLARK COUNTY, NEVADA, AS SHOWN IN FILE 65 OF SURVEYS, AT PAGE 69, OFFICIAL RECORDS OF CLARK COUNTY, NEVADA.

# **BENCHMARK**

CLARK COUNTY VERTICAL CONTROL V.2003 POINT "6C11 23NWW6", BEING A RIVET AND SQUARE ALUMINUM PLATE IN THE TOP OF CURB, NORTHEAST CORNER OF MARYLAND PARKWAY AND ROCHELLE AVENUE NEAR THE PC OF MARYLAND PARKWAY.

ELEVATION: 2009.29 (US SURVEY FEET) 612.434 (METERS)

CLARK COUNTY VERTICAL CONTROL V.2003 BASED ON NORTH AMERICAN VERTICAL DATUM OF 1988 (NAVD 88).

# FLOOD ZONE NOTE:

AS SHOWN BY FLOOD INSURANCE RATE MAP NO. 32003C2557F, DATED NOVEMBER 16, 2011, AN UNSHADED ZONE X, AREA DETERMINED TO BE OUTSIDE THE 0.2% ANNUAL CHANCE

	PRIVATE QUAN	<u>TITIES</u>	
ITE	M DESCRIPTION	QUANTITY	UNI
1. 2. 3.	CURB OPENING RIP RAP DF50=4", T=8" 2.5" AC PAVING OVER 6" TYPE II OVER	2 60	E.A SF
4.	4" TYPE I AGGREGATE BASE	94,957	SF
	CURB AND GUTTER "L" TYPE	750	LF
5.	CURB AND GUTTER "A" TYPE	1,479	LF
6.	O" MOW CURB	249	LF
7.	ADA RAMP	11	EA
8.	SIDEWALK UNDERDRAIN	2	EA
9.	CONCRETE SIDEWALK CONCRETE VALLEY GUTTER MODIFIED NDOT TYPE 2A DROP INLET	7,479	SF
10.		1,688	SF
11.		1	EA
12.	4" PVC SD	44	LF
13.	TYPE II CONCRETE HEADWALL	1	E <i>A</i>

# **ABBREVIATIONS**

ASPHALTIC CONCRETE ASBESTOS CEMENT PIPE AMERICAN NATIONAL STANDARDS INSTITUTE AMERICAN SOCIETY OF TESTING MATERIALS AVENUE AMERICAN WATER WORKS ASSOCIATION BACK OF CURB BACK OF CURB RADIUS BOUNDARY LINE BUILDING BOULEVARD	NAP NDOT NFPA NIC NTS OC PB PC PCC PI	NOT APPLICABLE NOT A PART NEVADA DEPT OF TRANSPORTATION NATIONAL FIRE PROTECTIONS ASSOC NOT IN CONTRACT NOT TO SCALE ON CENTER PULL BOX POINT OF CURVE POINT OF COMPOUND CURVE POINT OF INTERSECTION
BOUNDARY LINE BUILDING BOULEVARD BLOW OFF ASSEMBLY BOTTOM OF PIPE BOTTOM BEGINNING OF VERTICAL CURVE BACK WATER VALVE CLARK COUNTY AREA	PC PCC PI PKWY PL PP PT PNT PSI	POINT OF CURVE POINT OF COMPOUND CURVE POINT OF INTERSECTION PARKWAY PROPERTY LINE POWER POLE POINT OF TANGENCY POINT POUNDS PER SQUARE INCH
UNIFORM STANDARD DRAWING CLARK COUNTY WATER RECLAMATION DISTRICT CURB AND GUTTER CABLE TELEVISION CAST IRON PIPE	PRC PR PRV PRVT PVC	POINT OF REVERSE CURVE PROPOSED PRESSURE REGULATING VALVE PRIVATE POLYVINYL CHLORIDE PIPE

QUANTITY

RADIUS

ASSEMBLY

RIGHT OF WAY

STORM DRAIN

SQUARE YARD

STREET LIGHT

TOP OF CURB

TOP OF MANHOLE TOP OF FOOTING

UNIFORM DESIGN AND CONSTRUCTION

STANDARDS FOR POTABLE WATER

TOP OF GRATE

TELEPHONE

TEMPORARY

TELEPHONE

TOP OF PIPE

SYSTEMS

UTILITIES

WATER

YARD

UNDERGROUND

VERTICAL CURVE

VALLEY GUTTER

WATER METER

VITRIFIED CLAY PIPE

TOP OF WALL TRAFFIC SIGNAL

SIDEWALK/SOUTHWEST

RAILROAD

STATION

RCB

RPPA

R/W

STA

STLT

TOP/TP

UG UTIL

VC

VG WTR

PRESSURE REGULATING VALVE POLYVINYL CHLORIDE PIPE ENGINEER-SX POINT OF VERTICAL INTERSECTION PAVEMENT RATE OF FLOW THAI Q. TRAN REINFORCED CONCRETE REINFORCED CONCRETE BOX EXP. 6-30-2018 REINFORCED CONCRETE PIPE CIVIL REDUCED PRESSURE PRINCIPLE

No. 21 356 SQUARE FOOT (FEET) SANITARY SEWER

SHE 0 4

CEI PROJECT: TQT DESIGN BY: TQT/SS DRAWN BY: CHECKED BY: DATE:

> 12/21/2016 SCALE:

SHEET NUMBER

SHEET 02 OF 08

**DEVIATIONS FROM STANDARDS** NONE

COLLINS ENGINEERS INC., ASSUMES NO RESPONSIBILITY FOR EXISTING UTILITY LOCATIONS AND ELEVATIONS. THE UTILITIES SHOWN ON THIS DRAWING HAVE BEEN PLOTTED FROM THE BEST AVAILABLE INFORMATION. IT IS, HOWEVER, THE CONTRACTOR'S RESPONSIBILITY TO FIELD VERIFY THE LOCATION AND ELEVATION OF ALL UTILITIES PRIOR TO THE COMMENCEMENT OF ANY CONSTRUCTION. CONTRACTOR TO FIELD VERIFY ALL EXISTING SITE CONDITIONS PRIOR TO CONSTRUCTION. IF A CONFLICT EXISTS BETWEEN WHAT IS SHOWN ON THESE DRAWINGS AND WHAT EXISTS IN THE FIELD, THE CONTRACTOR IS TO NOTIFY THE ARCHITECT OR ENGINEER









H:\CAD\LAND\9937\DWG\SHEETS\9937-C1.02-NTS.DWG 01/18/2017 03:20:02 PM

BACK OF CURB RADIUS BOUNDARY LINE BUILDING BLVD BOULEVARD BLOW OFF ASSEMBLY BOTTOM OF PIPE BACK WATER VALVE

BEGINNING OF VERTICAL CURVE CLARK COUNTY AREA CCUSD UNIFORM STANDARD DRAWING CCWRD CLARK COUNTY WATER RECLAMATIO CURB AND GUTTER CABLE TELEVISION

CATV CAST IRON PIPE CENTERLINE CLEAN OUT CLEAR CONCRETE MASONRY UNIT

CMU CORRUGATED METAL PIPE CONC CONCRETE COND CONDUIT CU FT CUBIC FOOT CU YD CUBIC YARD

ASTM

AWWA

DCDA DCVA DEMO DROP INLET

DOUBLE CHECK DETECTOR ASSEMBLY DOUBLE CHECK VALVE ASSEMBLY DEMOLITION DI DIP DWG DUCTILE IRON PIPE DRAWING END OF CURVE

END OF CURB RETURN ENERGY GRADE LINE END OF VERTICAL CURVE EDGE OF PAVEMENT FIRE DEPARTMENT CONNECTION FINISHED FLOOR FINISHED GRADE FIRE HYDRANT

**FMCT** FLOW METER COMPOUND TORRENT FACE OF CURB FOOT OR FEET GRADE BREAK GATE VALVE

INV INVERT LOMR


HYDRAULIC GRADE LINE HIGH POINT LINEAR FOOT LOW POINT LANDSCAPE LVVWD MATCH EXISTING

MINIMUM

LETTER OF MAP REVISION LAS VEGAS VALLEY WATER DISTRICT MANHOLE

DDU/ATE OLIANITITIES

Ö

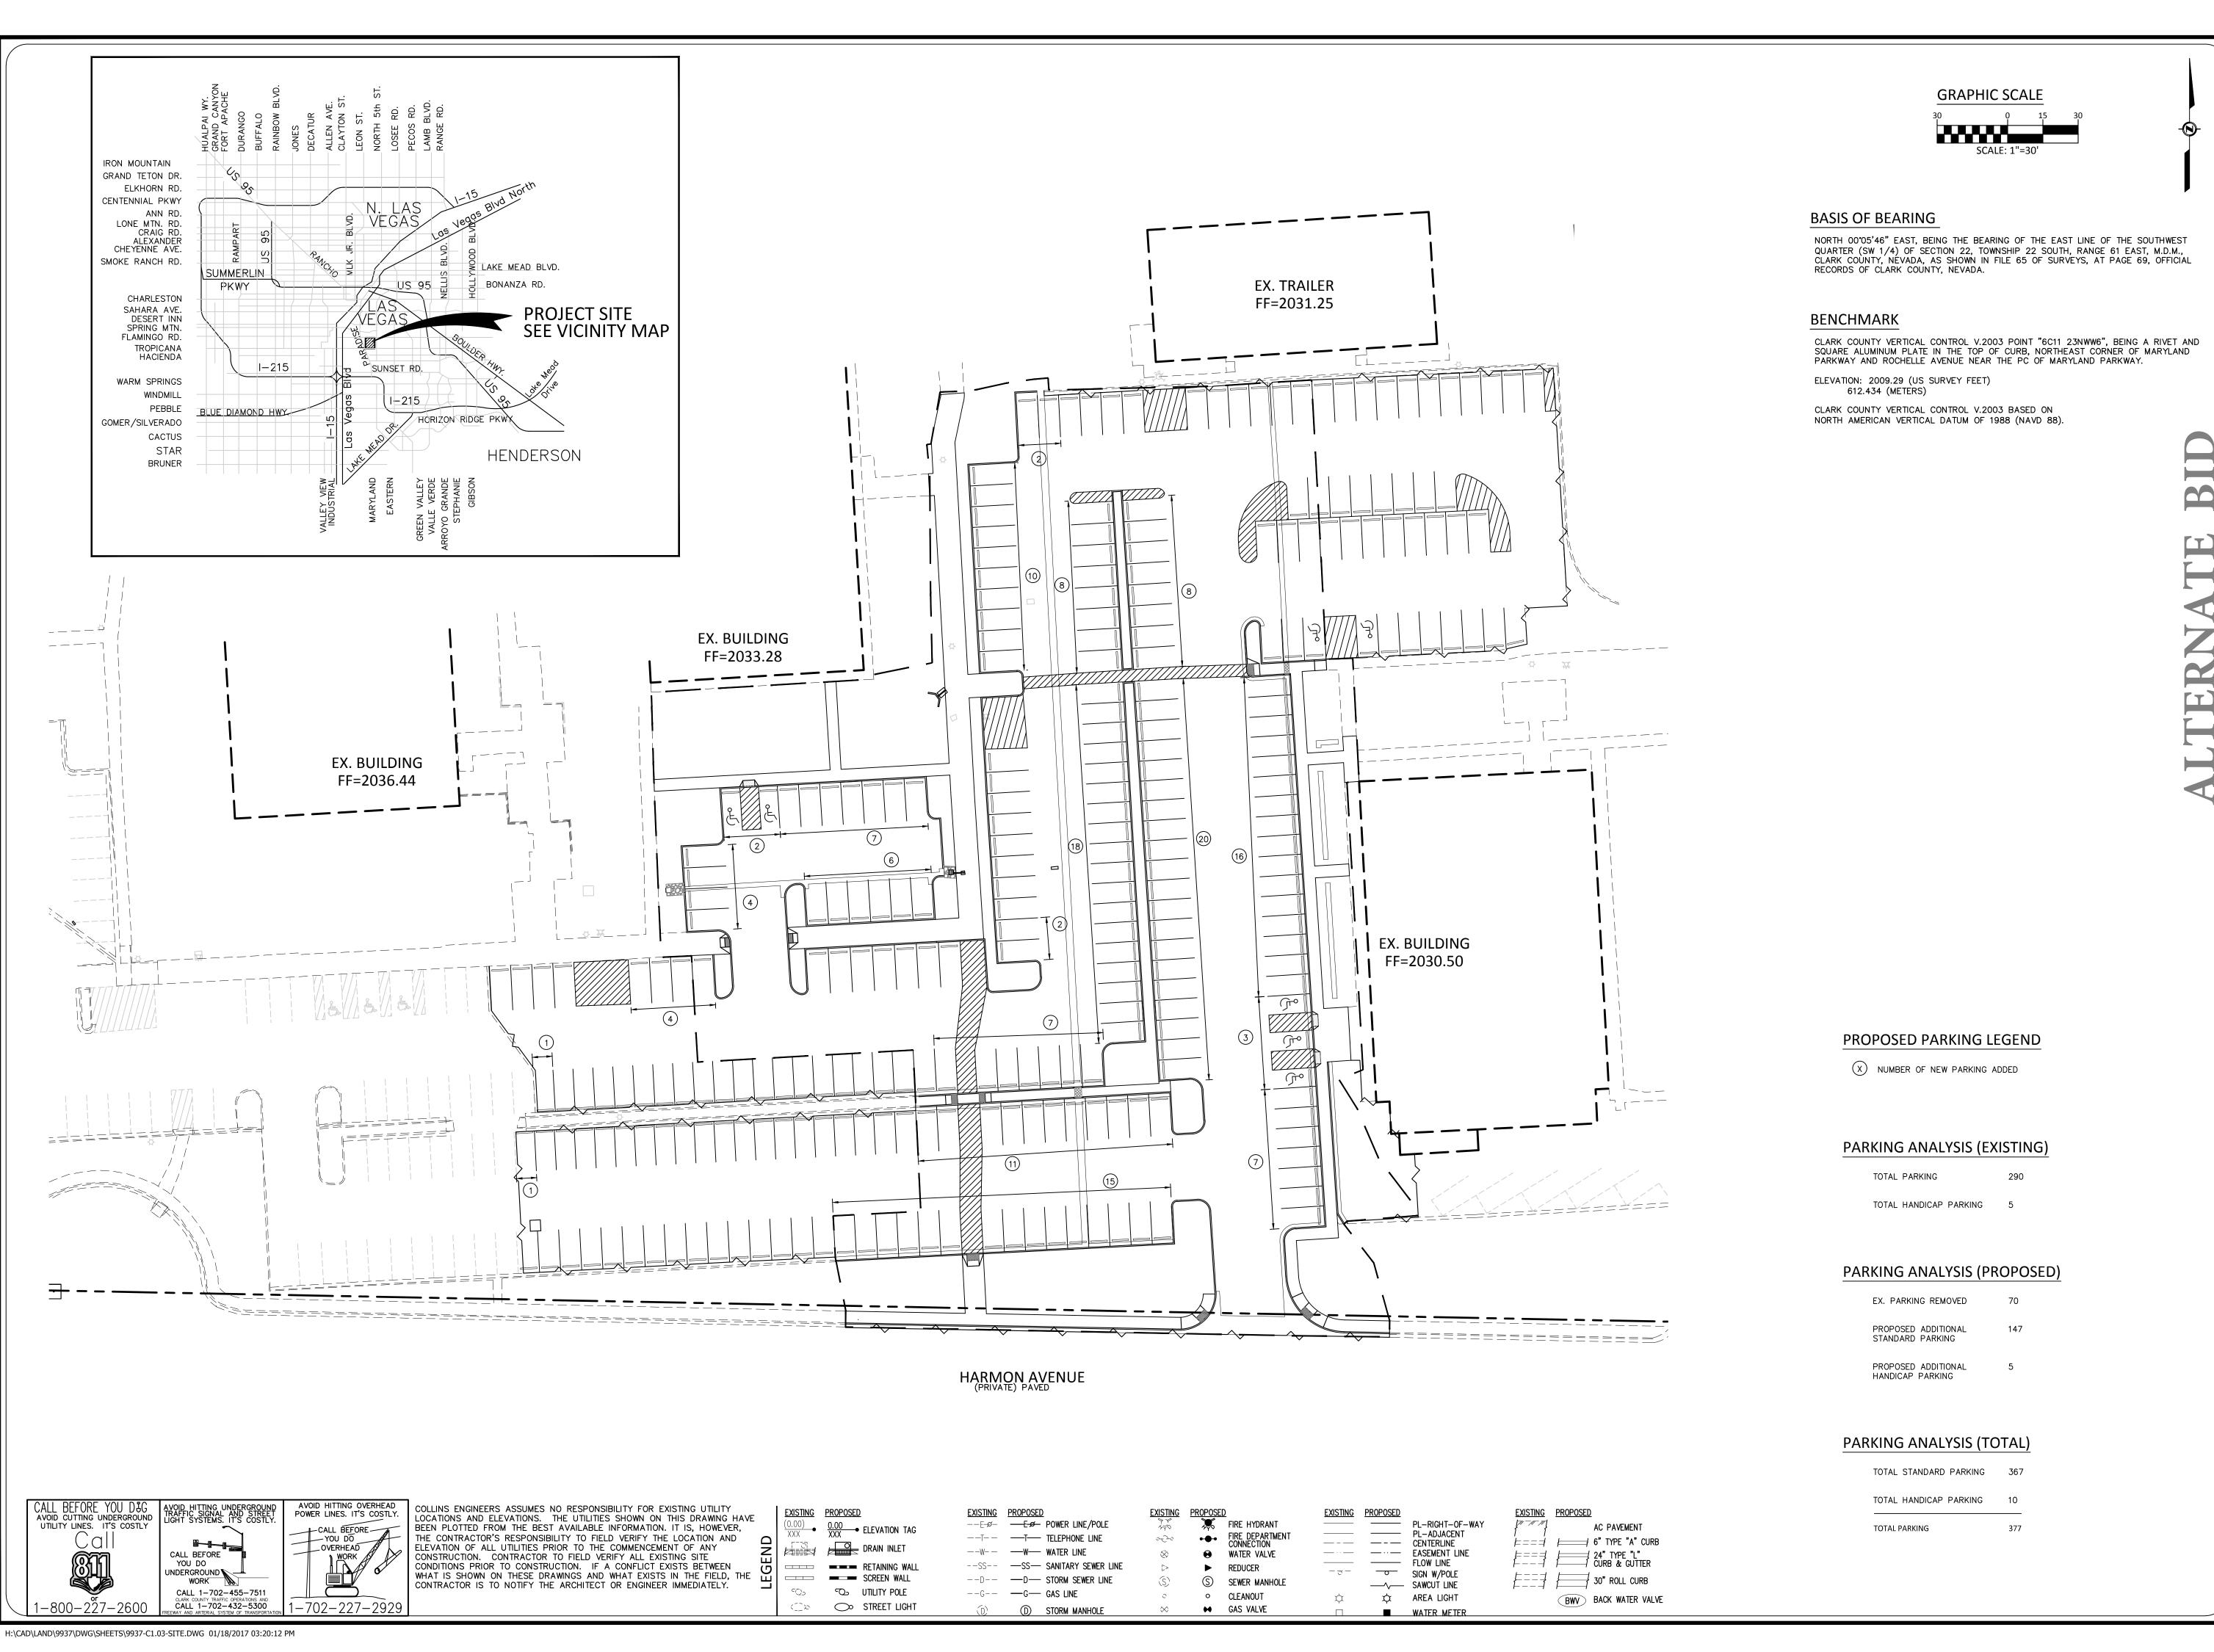

FNGINEER-, C. TRAN EXP. 6-30-2018

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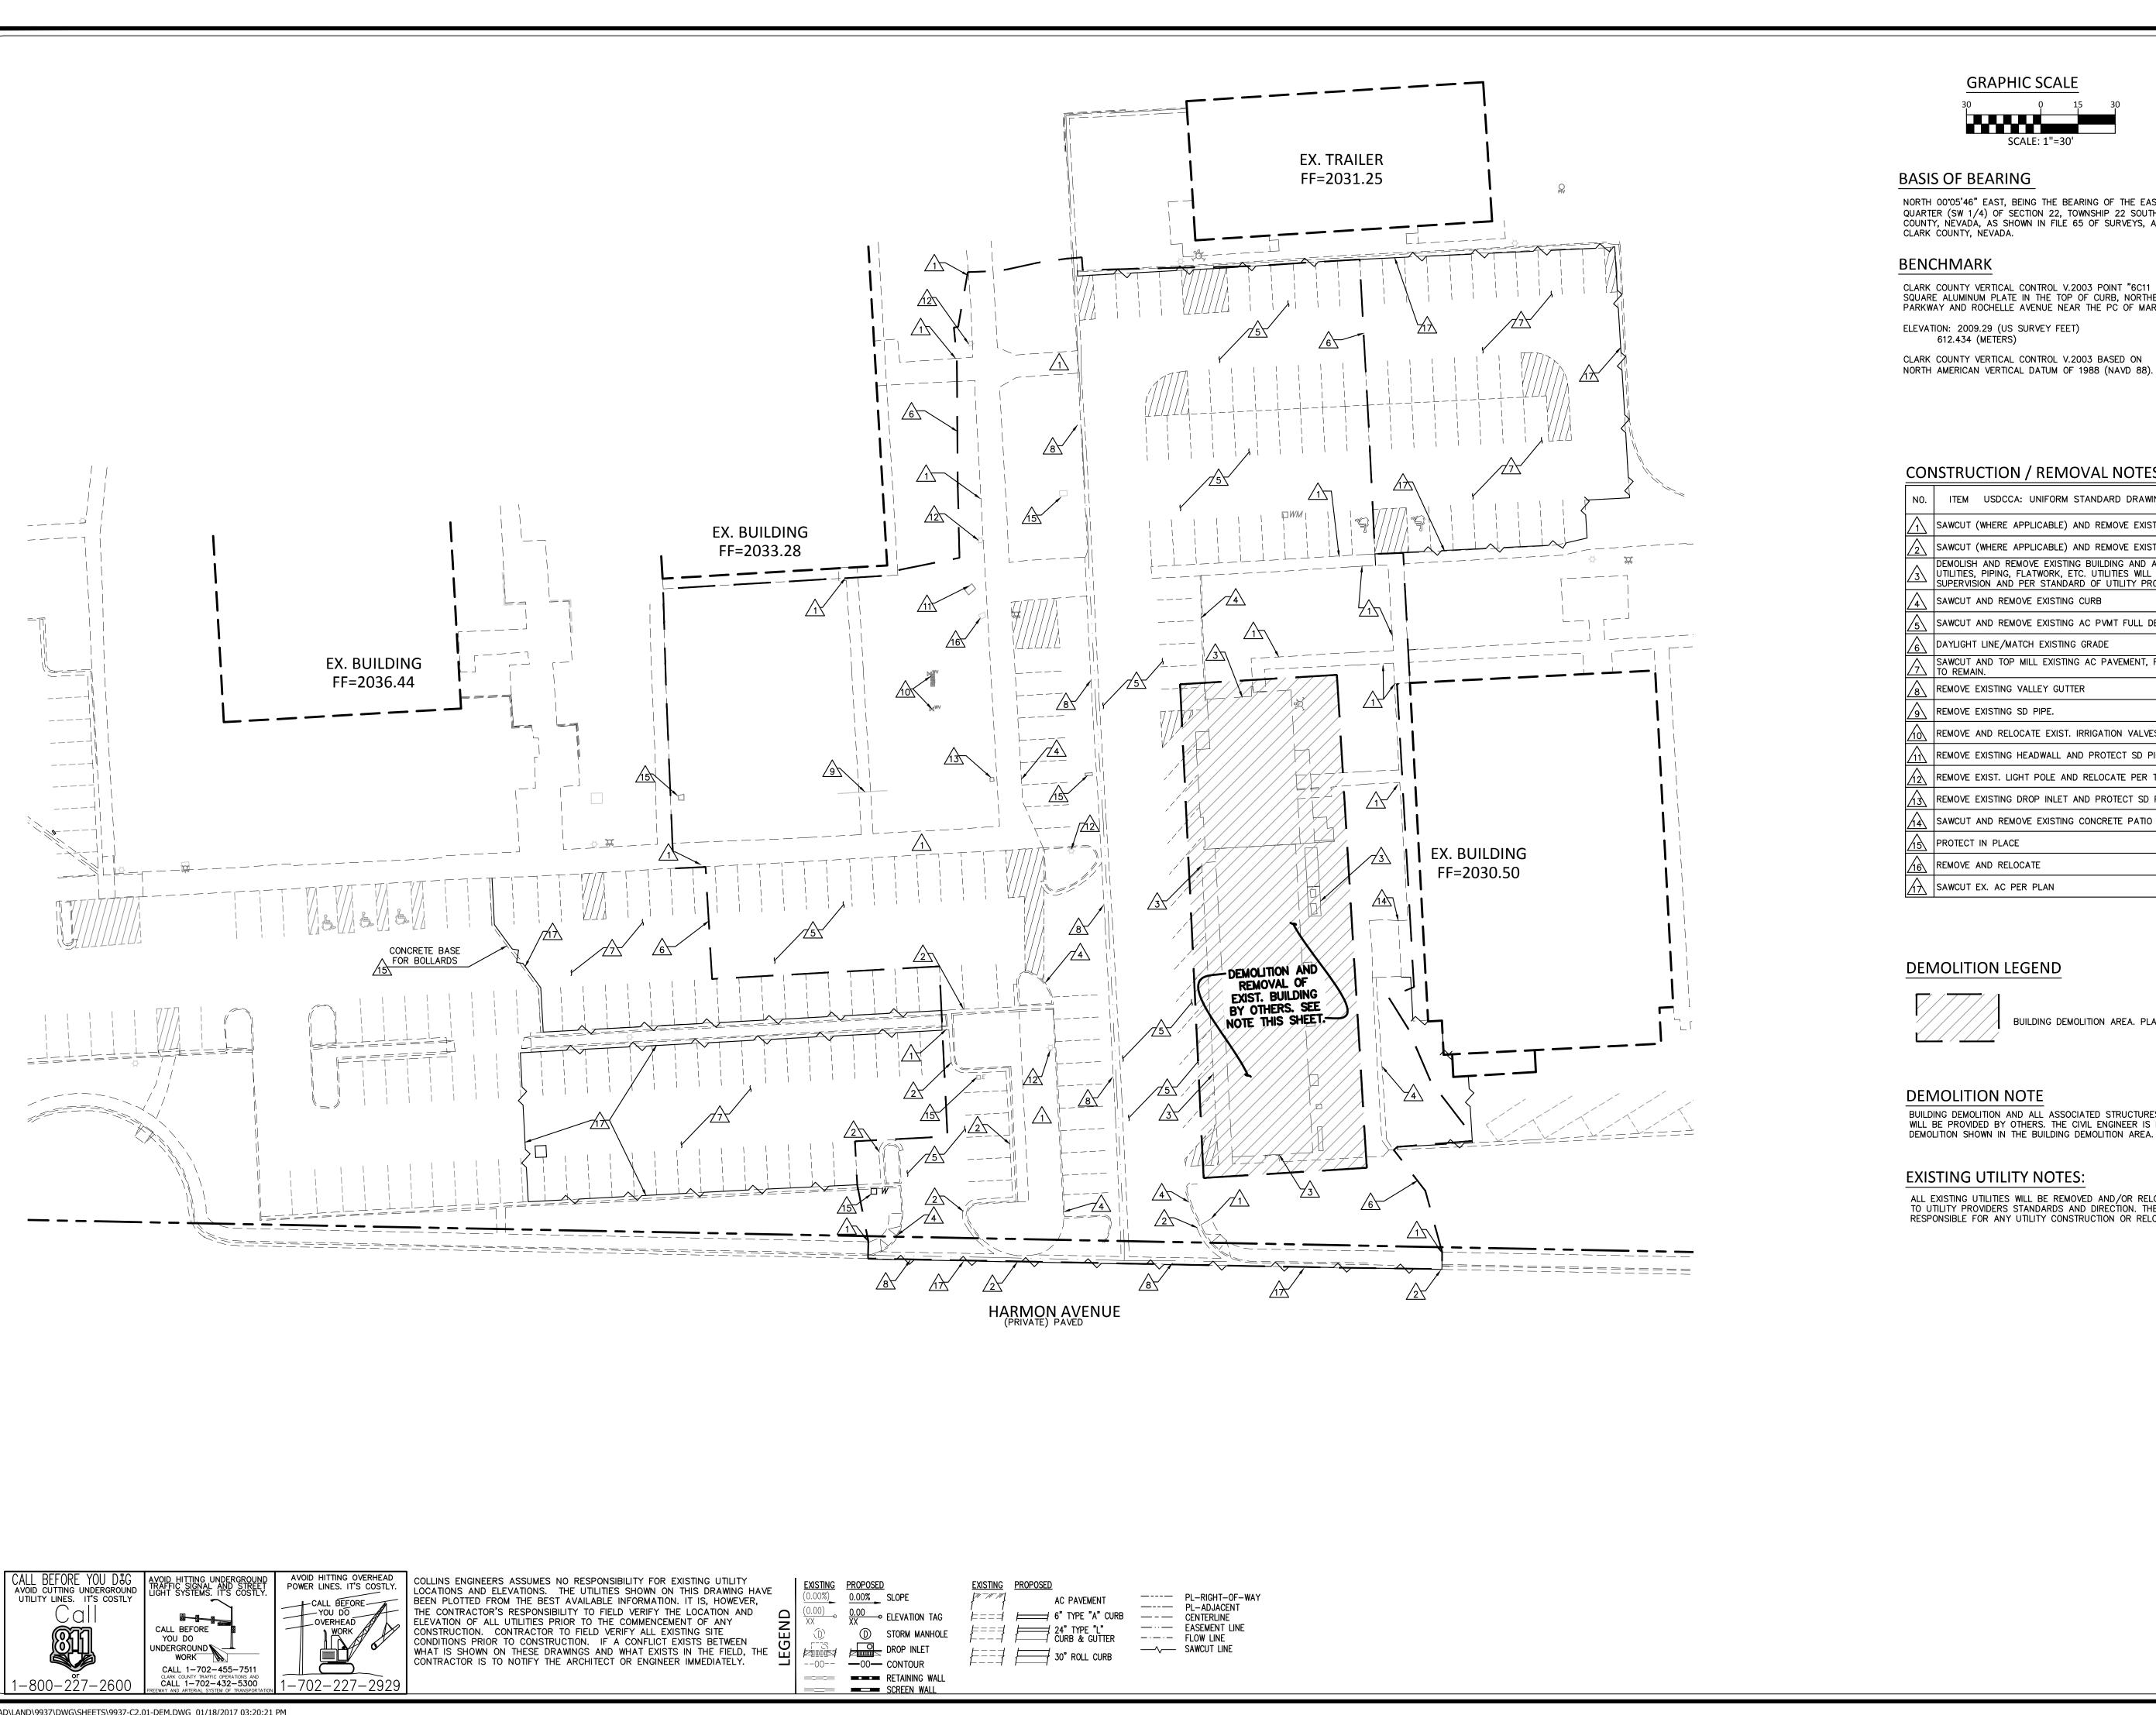
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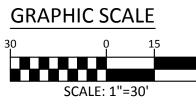
SCALE:

SHEET NUMBER

C1.03

SHEET 03 OF 08





NORTH 00°05'46" EAST, BEING THE BEARING OF THE EAST LINE OF THE SOUTHWEST QUARTER (SW 1/4) OF SECTION 22, TOWNSHIP 22 SOUTH, RANGE 61 EAST, M.D.M., CLARK COUNTY, NEVADA, AS SHOWN IN FILE 65 OF SURVEYS, AT PAGE 69, OFFICIAL RECORDS OF

CLARK COUNTY VERTICAL CONTROL V.2003 POINT "6C11 23NWW6", BEING A RIVET AND SQUARE ALUMINUM PLATE IN THE TOP OF CURB, NORTHEAST CORNER OF MARYLAND PARKWAY AND ROCHELLE AVENUE NEAR THE PC OF MARYLAND PARKWAY.

CLARK COUNTY VERTICAL CONTROL V.2003 BASED ON

# CONSTRUCTION / REMOVAL NOTES

NO.	ITEM USDCCA: UNIFORM STANDARD DRAWINGS CLARK COUNTY AREA.
$\rightarrow$	SAWCUT (WHERE APPLICABLE) AND REMOVE EXISTING CONCRETE WALK
2	SAWCUT (WHERE APPLICABLE) AND REMOVE EXISTING CURB AND GUTTER
	DEMOLISH AND REMOVE EXISTING BUILDING AND ALL ASSOCIATED STRUCTURES, UTILITIES, PIPING, FLATWORK, ETC. UTILITIES WILL BE STUBBED & CAPPED UNDER SUPERVISION AND PER STANDARD OF UTILITY PROVIDER. SEE NOTE THIS SHEET.
4	SAWCUT AND REMOVE EXISTING CURB
>	

SAWCUT AND REMOVE EXISTING AC PVMT FULL DEPTH

SAWCUT AND TOP MILL EXISTING AC PAVEMENT, FULL DEPTH, EXISTING SUBBASE TO REMAIN.

REMOVE AND RELOCATE EXIST. IRRIGATION VALVES AND METERS

REMOVE EXISTING HEADWALL AND PROTECT SD PIPE IN PLACE

REMOVE EXIST. LIGHT POLE AND RELOCATE PER TRAFFIC & SIGNAGE SHEET, C.60°

REMOVE EXISTING DROP INLET AND PROTECT SD PIPE IN PLACE

BUILDING DEMOLITION AREA. PLAN AND SPECIFICATIONS BY OTHERS.

BUILDING DEMOLITION AND ALL ASSOCIATED STRUCTURES, UTILITIES, FLATWORK, AND PIPING WILL BE PROVIDED BY OTHERS. THE CIVIL ENGINEER IS NOT RESPONSIBLE FOR ANY DEMOLITION SHOWN IN THE BUILDING DEMOLITION AREA.

ALL EXISTING UTILITIES WILL BE REMOVED AND/OR RELOCATED BY OTHERS IN ACCORDANCE TO UTILITY PROVIDERS STANDARDS AND DIRECTION. THE CIVIL ENGINEER IS NOT RESPONSIBLE FOR ANY UTILITY CONSTRUCTION OR RELOCATION.

TRAN


EXP. 6-30-2018

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CHECKED BY: DATE: 12/21/2016 SCALE:


SHEET NUMBER

SHEET 04 OF 08

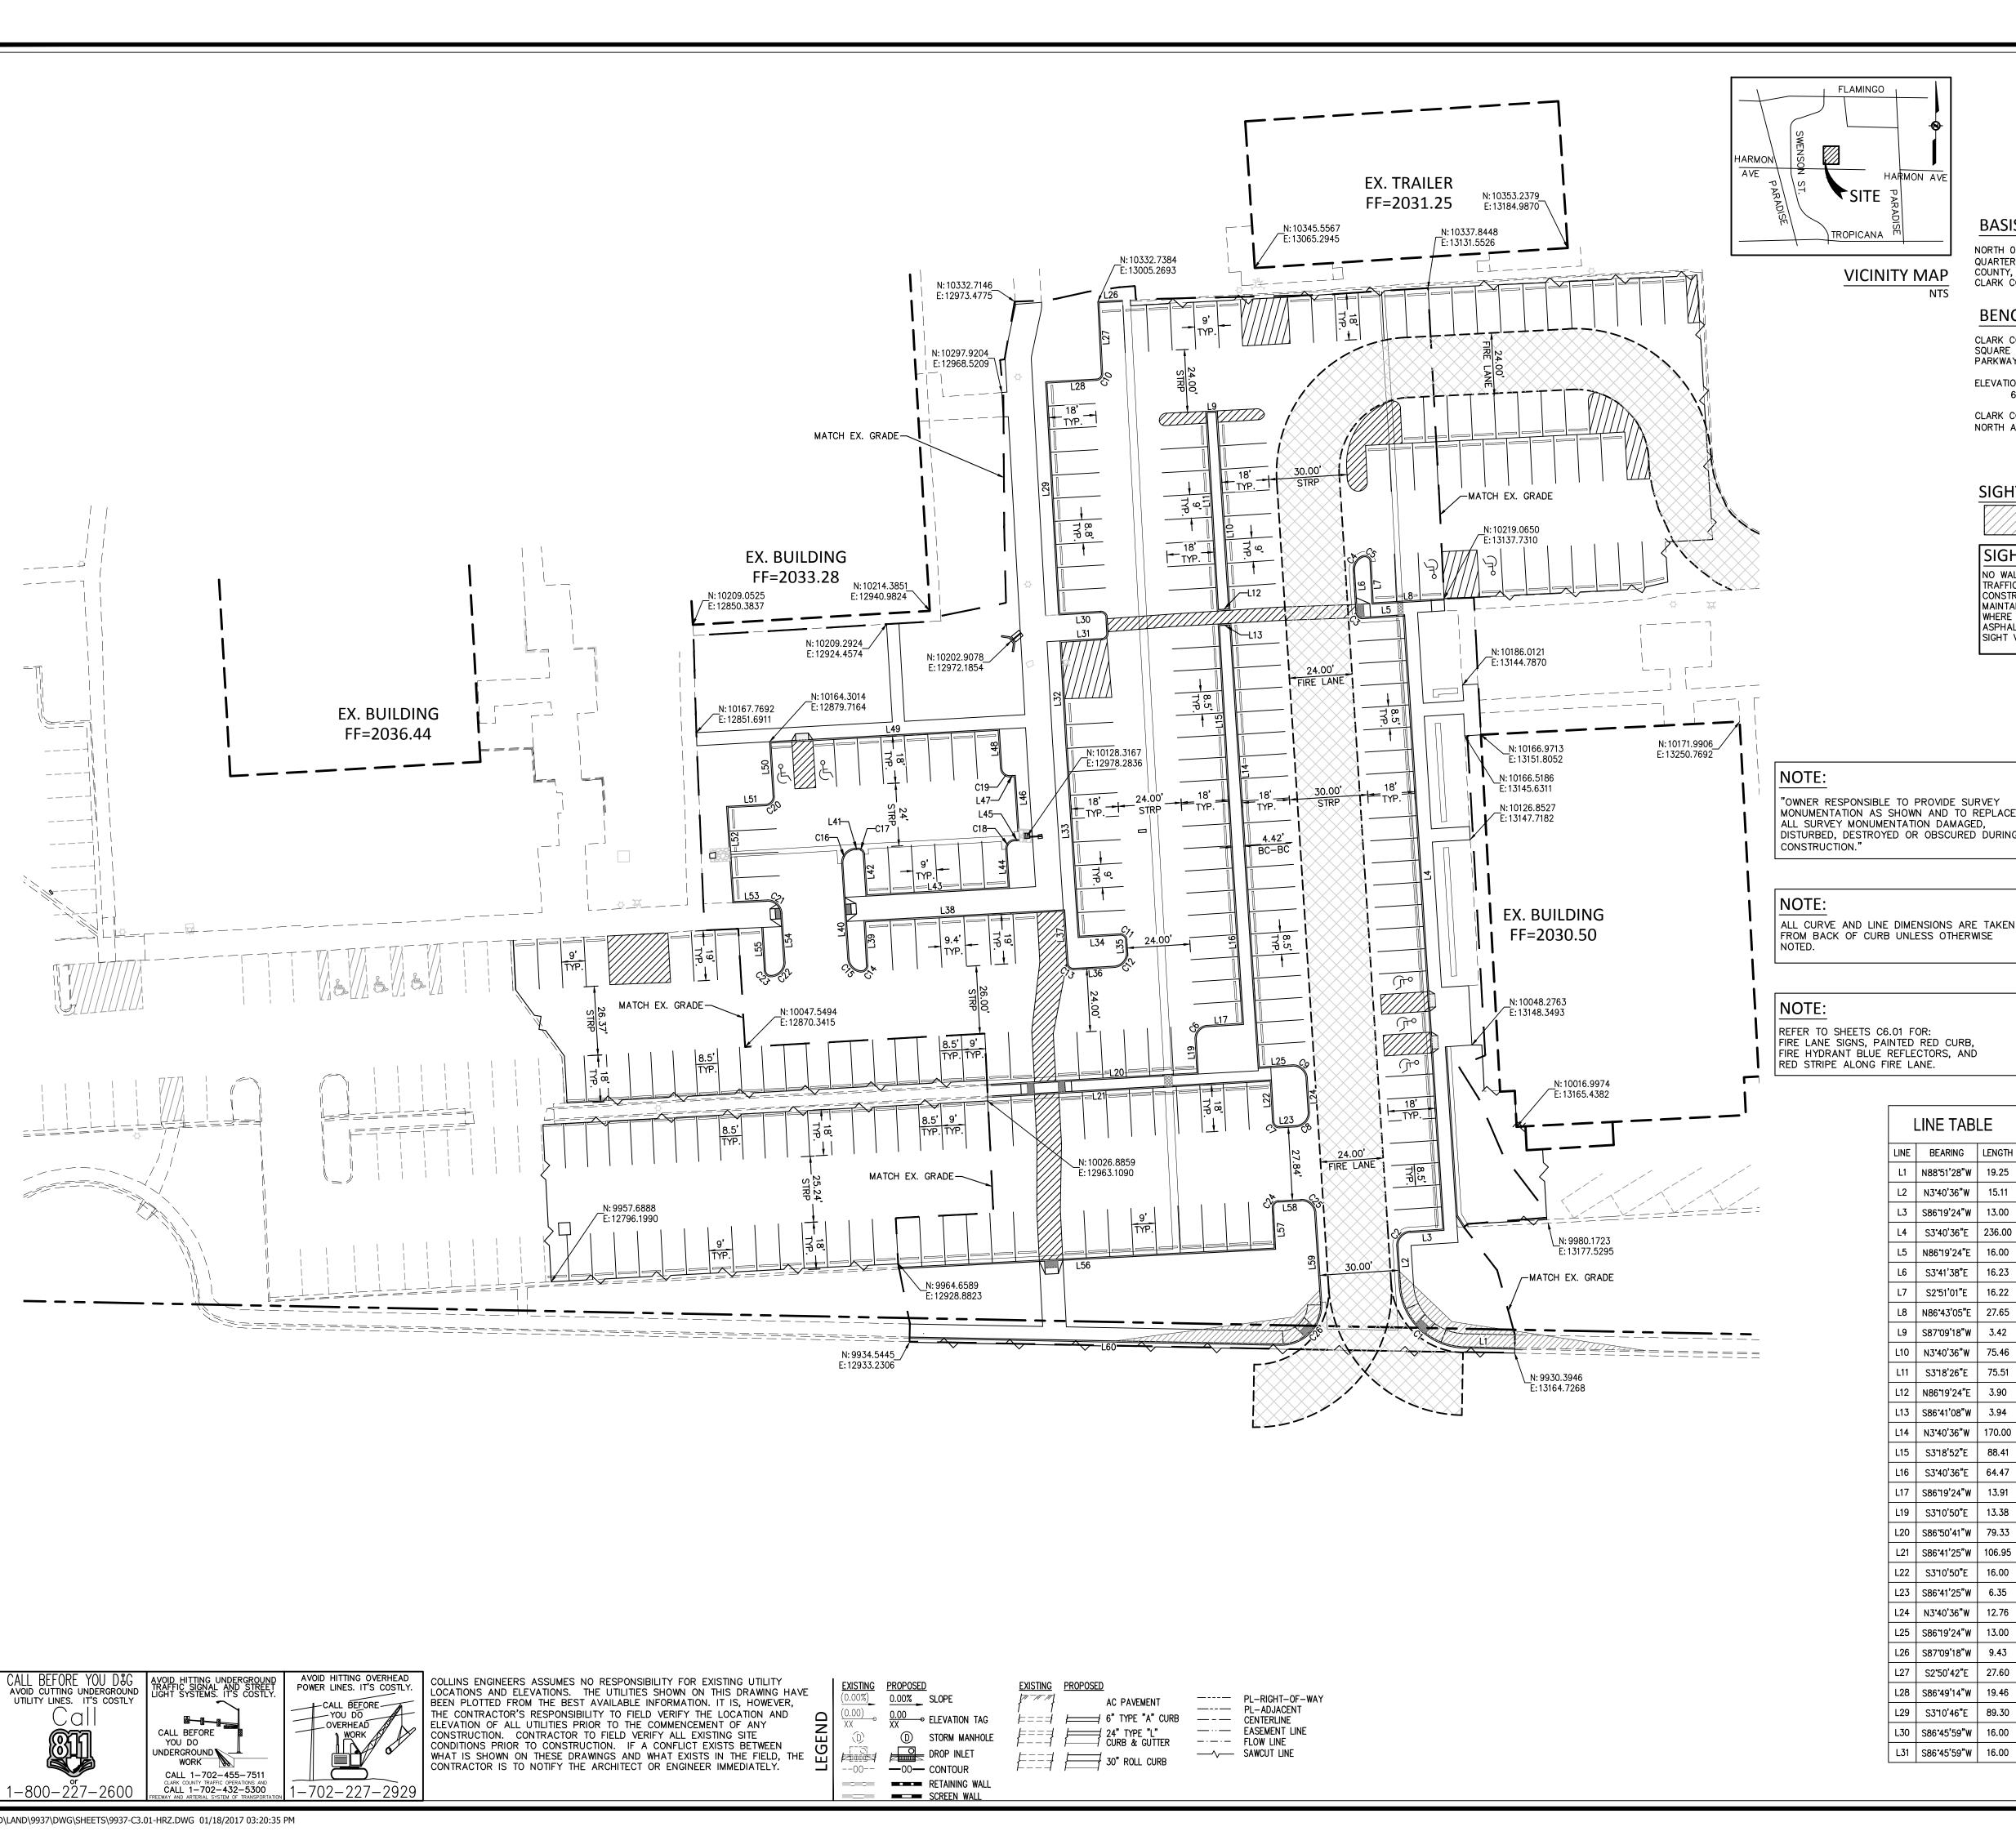

BASIS OF BEARING

**GRAPHIC SCALE** SCALE: 1"=30'

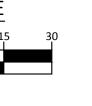

NORTH 00°05'46" EAST, BEING THE BEARING OF THE EAST LINE OF THE SOUTHWEST QUARTER (SW 1/4) OF SECTION 22, TOWNSHIP 22 SOUTH, RANGE 61 EAST, M.D.M., CLARK COUNTY, NEVADA, AS SHOWN IN FILE 65 OF SURVEYS, AT PAGE 69, OFFICIAL RECORDS OF CLARK COUNTY, NEVADA.

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## ELEVATION: 2009.29 (US SURVEY FEET) 612.434 (METERS)

CLARK COUNTY VERTICAL CONTROL V.2003 BASED ON NORTH AMERICAN VERTICAL DATUM OF 1988 (NAVD 88).

# SIGHT VISIBILITY ZONE LEGEND

SIGHT VISIBILITY ZONE

# SIGHT VISIBILITY ZONE NOTE:

NO WALLS, FENCES SHRUBS, UTILITY APPURTENANCES OR ANY OTHER OBJECT, OTHER THAN TRAFFIC CONTROL DEVICES, FIRE HYDRANTS, TREES, AND STREET LIGHT POLES, MAY BE CONSTRUCTED OR INSTALLED WITHIN THE SIGHT VISIBILITY ZONE UNLESS SAID OBJECT IS MAINTAINED AT LESS THAN 24 INCHES IN HEIGHT, MEASURED FROM TOP OF CURB, OR WHERE NO CURB EXISTS. A HEIGHT OF 27 INCHES MEASURED FROM THE TOP OF ADJACENT ASPHALT, GRAVEL OR PAVEMENT STREET SURFACE. THIS RESTRICTION EXTENDS ALONG THE SIGHT VISIBILITY LINE THROUGH LANDSCAPE MEDIANS.

# FIRE LANE LEGEND

"OWNER RESPONSIBLE TO PROVIDE SURVEY MONUMENTATION AS SHOWN AND TO REPLACE ALL SURVEY MONUMENTATION DAMAGED, DISTURBED, DESTROYED OR OBSCURED DURING

ALL CURVE AND LINE DIMENSIONS ARE TAKEN FROM BACK OF CURB UNLESS OTHERWISE

FIRE LANE SIGNS, PAINTED RED CURB, FIRE HYDRANT BLUE REFLECTORS, AND

# LANE" PAINTED EVERY 100 FT. PER CITY OF LAS VEGAS FIRE DEPARTMENT GUIDELINES. INDICATES PROPOSED LOCATION OF FIRE LANE SIGNS TO BE PLACED AT 100' INCREMENTS. FIRE LANE SIGNS SHALL CONFORM TO CITY OF LAS VEGAS FIRE DEPARTMENT

# INSTALL BLUE COLORED REFLECTIVE RAISED PAVEMENT MARKERS ADJACENT TO THE FIRE HYDRANT ON ALL IMPROVED FIRE APPARATUS ACCESS ROADWAYS WITH HARD SURFACES, INCLUDING BOTH PUBLIC AND PRIVATE ROADS, STREETS, OR FIRE LANES: ON ROADWAYS WITH NO PARKING PERMITTED ON THE HYDRANT SIDE; EIGHT (8) FEET FROM THE FACE OF TH CURB ON THE HYDRANT SIDE. ON ROADWAYS WITH PARKING PERMITTED ON THE HYDRANT SIDE; (16) FEET FROM THE FACE OF THE CURB ON THE HYDRANT SIDE. INDICATES 24' MINIMUM WIDTH FIRE LANE AND TYPICAL TURNING RADIUS PER CITY OF LAS VEGAS FIRE DEPARTMENT GUIDELINES R=28' (MIN)

INDICATES RED PAINTED CURB WITH "NO PARKING - FIRE

	LINE TAB	LE		LINE TAB	LE
LINE	BEARING	LENGTH	LINE	BEARING	LENGTH
L1	N88°51'28"W	19.25	L32	S310'46"E	39.85
L2	N3°40'36"W	15.11	L33	S3°40'36"E	71.68
L3	S86°19'24"W	13.00	L34	S86°46'54"W	16.02
L4	S3°40'36"E	236.00	L35	N3°40'36"W	4.69
L5	N86*19'24"E	16.00	L36	S86°50'41"W	15.47
L6	S3°41'38"E	16.23	L37	S3°40'36"E	20.57
L7	S2*51'01"E	16.22	L38	N86°55'23"E	56.24
L8	N86°43'05"E	27.65	L39	N312'54"W	17.12
L9	S87°09'18"W	3.42	L40	N3°40'36"W	36.47
L10	N3°40'36"W	75.46	L41	N86°51'19"E	0.97
L11	S318'26"E	75.51	L42	S3°40'36"E	16.02
L12	N86*19'24"E	3.90	L43	N86°51'19"E	55.00
L13	S86°41'08"W	3.94	L44	N3°40'36"W	14.97
L14	N3°40'36"W	170.00	L45	S86°51'19"W	1.97
L15	S318'52"E	88.41	L46	S3°40'36"E	25.00
L16	S3°40'36"E	64.47	L47	S86°51'19"W	2.03
L17	S86*19'24"W	13.91	L48	N3°40'36"W	15.03
L19	S310'50"E	13.38	L49	N86°51'19"E	88.00
L20	S86°50'41"W	79.33	L50	S3°40'36"E	20.84
L21	S86°41'25"W	106.95	L51	N87"5'53"E	14.95
L22	S310'50"E	16.00	L52	S3°40'36"E	37.00
L23	S86°41'25"W	6.35	L53	N87"15'53"E	13.08
L24	N3°40'36"W	12.76	L54	S3°40'36"E	18.45
L25	S8619'24"W	13.00	L55	S3"18'51"E	16.52
L26	S87°09'18"W	9.43	L56	S87°02'16"W	144.50
L27	S2°50'42"E	27.60	L57	S2°55'36"E	16.00
L28	S86°49'14"W	19.46	L58	S87°02'16"W	8.60
L29	S3°10'46"E	89.30	L59	N3°40'36"W	34.19
L30	S86°45'59"W	16.00	L60	N88*56'02"W	141.91
L31	S86°45'59"W	16.00			

CURVE	LENGTH	RADIUS	DELTA	TANGENT
C1	37.17	25.00'	85"10'51"	22.98'
C2	7.85'	5.00'	90°00'00"	5.00'
C3	3.14'	2.00'	90°00'00"	2.00'
C4	6.29'	5.00'	72°05'53"	3.64
C5	3.80'	2.00'	108'43'42"	2.79'
C6	7.03'	4.50'	89°30'14"	4.46'
C7	3.15'	2.00'	90°07'44"	2.00'
C8	7.89'	5.00'	90°22'02"	5.03'
С9	7.85	5.00'	90°00'00"	5.00'
C10	3.13'	2.00'	89*39'56"	1.99'
C11	3.13'	2.00'	89*32'29"	1.98'
C12	7.90'	5.00'	90°31′18″	5.05
C13	3.12'	2.00'	89*28'42"	1.98'
C14	3.44'	2.00'	98°40'53"	2.33'
C15	7.06'	5.00'	80°51'24"	4.26'
C16	7.90'	5.00'	90°31'55"	5.05
C17	3.12'	2.00'	89*28'05"	1.98'
C18	4.74'	3.00'	90°31'55"	3.03'
C19	4.68'	3.00'	89*28'05"	2.97'
C20	4.76'	3.00'	90°56'30"	3.05'
C21	7.77	5.00'	89°03'30"	4.92'
C22	8.12'	5.00'	93°04'32"	5.28'
C23	3.05'	2.00'	87"17'14"	1.91'
C24	3.14'	2.00'	89*57'52"	2.00'
C25	7.79'	5.00'	8917'07"	4.94'
C26	24.80'	15.00'	94*44'34"	16.30'

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EXP. 6-30-2018

CEI PROJECT: DESIGN BY: TQT TQT/SS DRAWN BY:


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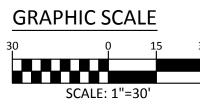
DATE: 12/21/2016 SCALE:

SHEET NUMBER

C3.01

SHEET 05 OF 08



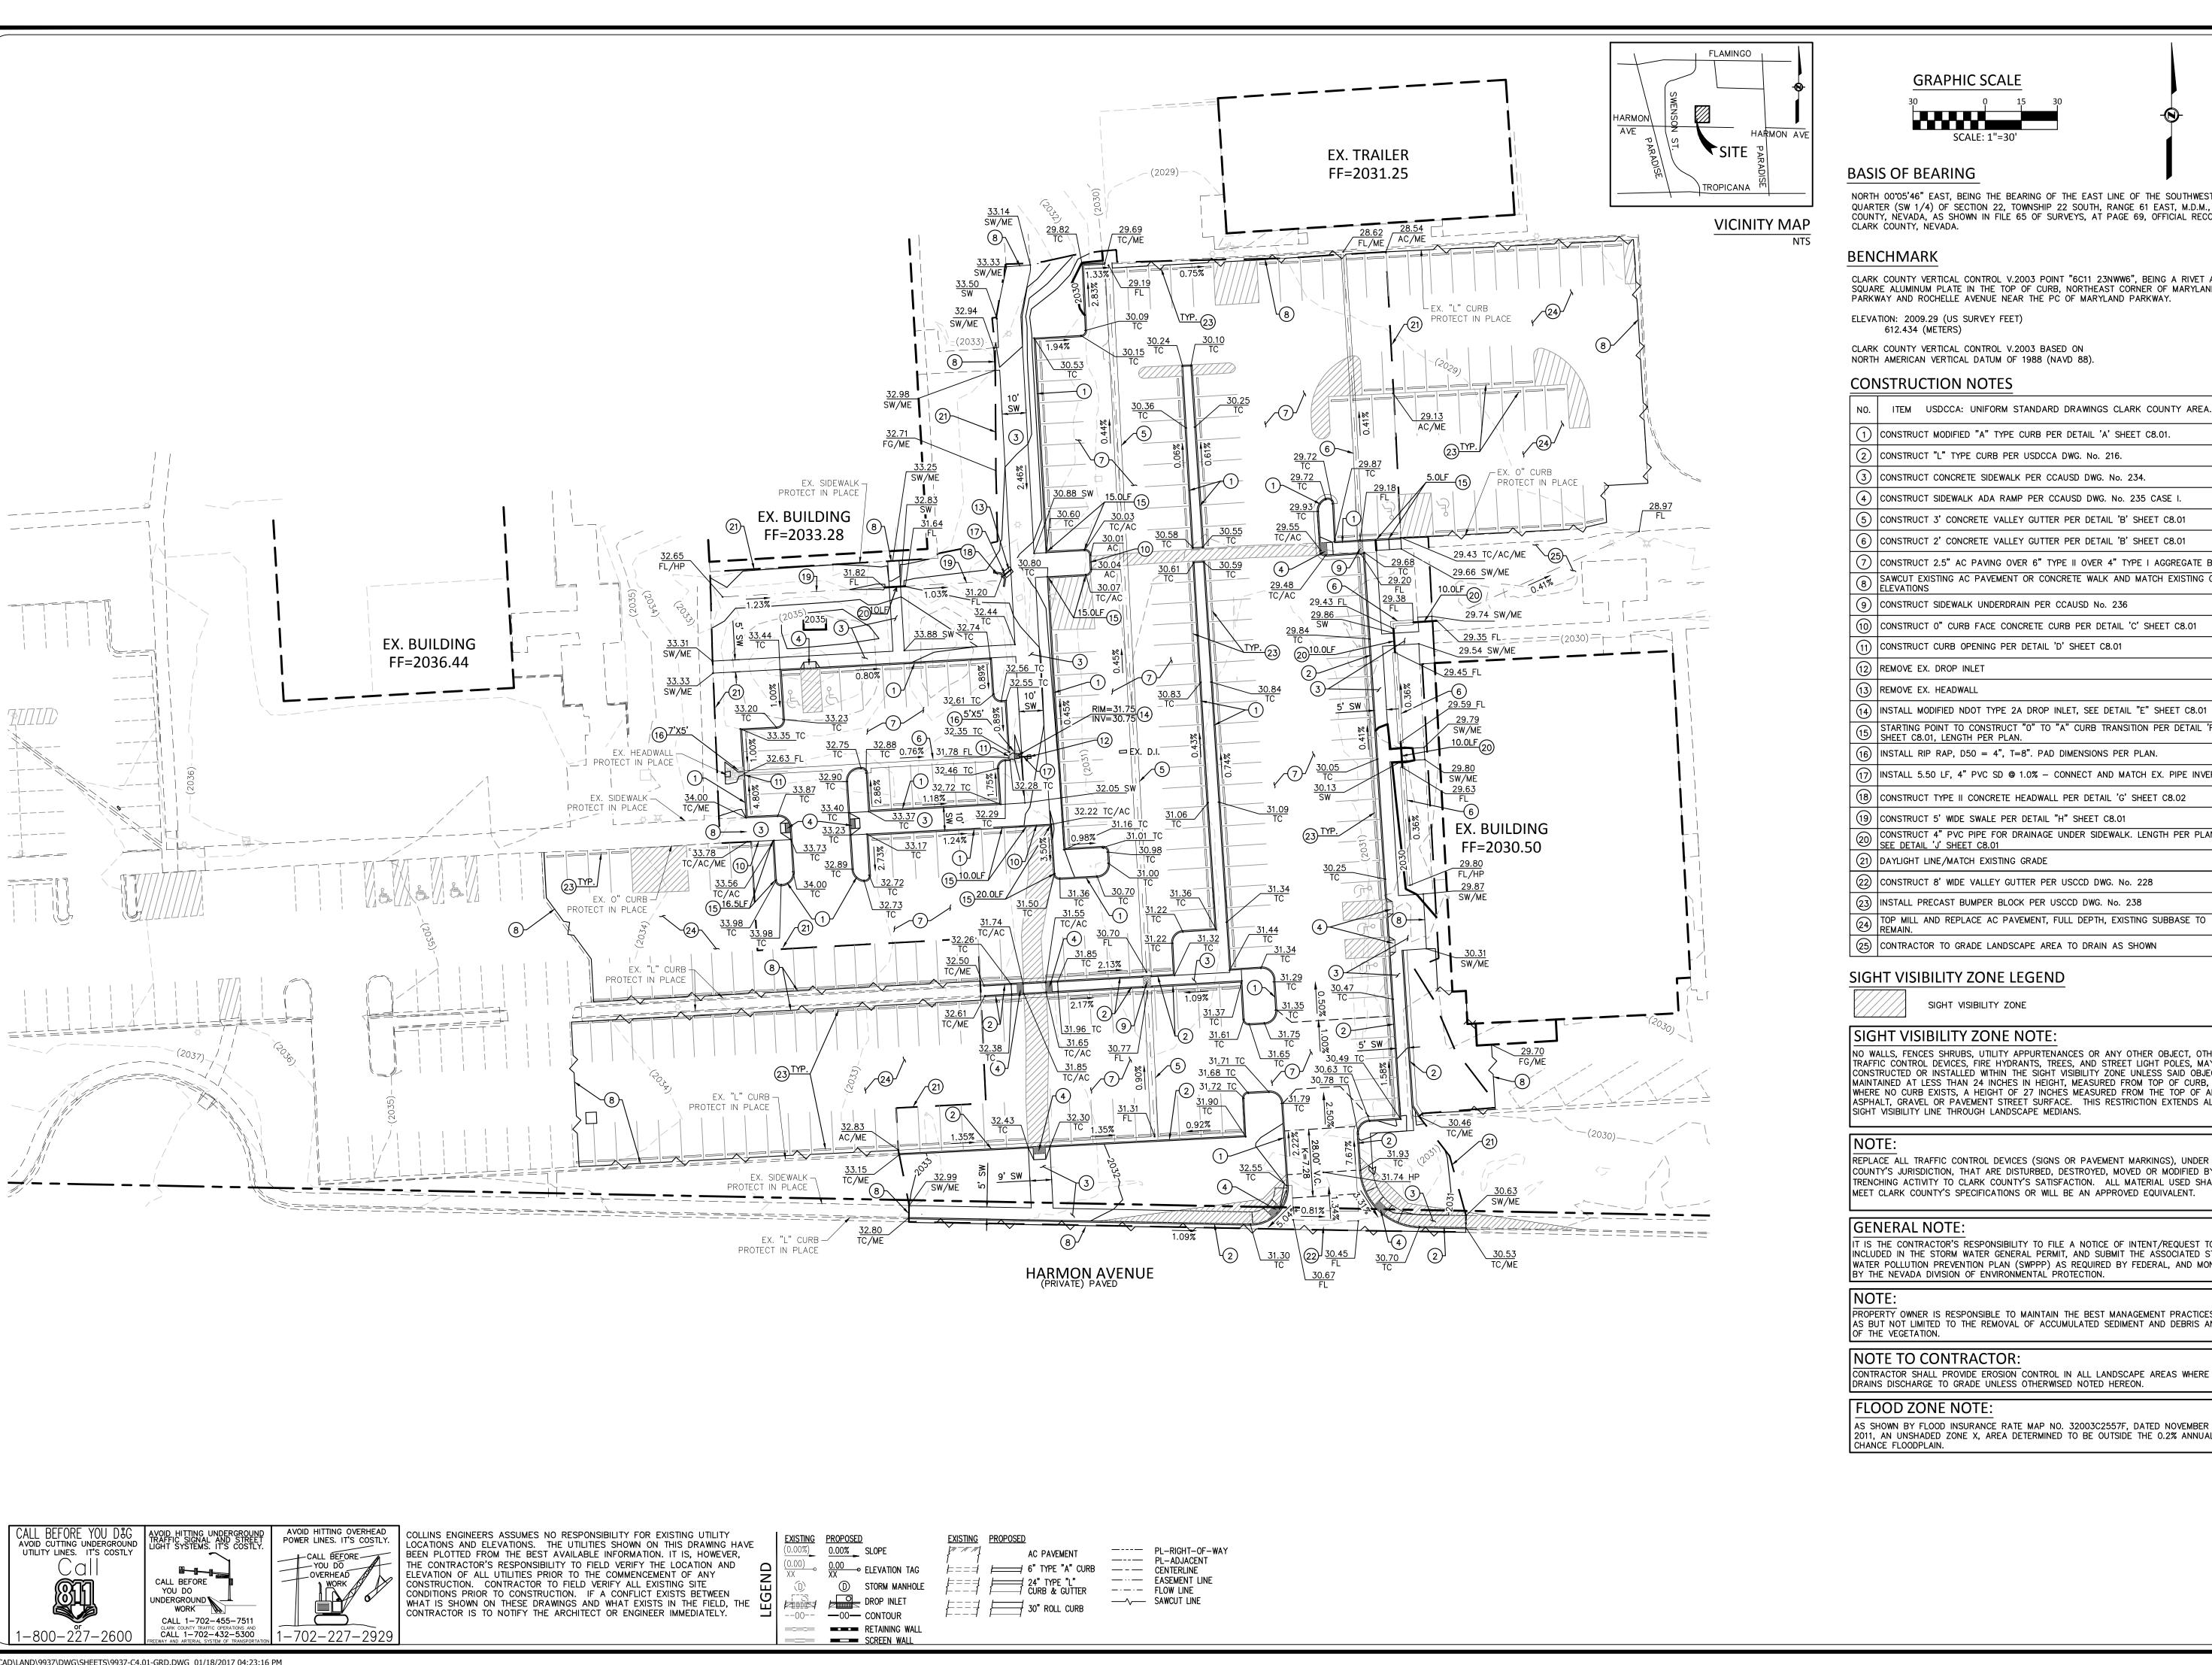

NORTH 00°05'46" EAST, BEING THE BEARING OF THE EAST LINE OF THE SOUTHWEST QUARTER (SW 1/4) OF SECTION 22, TOWNSHIP 22 SOUTH, RANGE 61 EAST, M.D.M., CLARK COUNTY, NEVADA, AS SHOWN IN FILE 65 OF SURVEYS, AT PAGE 69, OFFICIAL RECORDS OF

CLARK COUNTY VERTICAL CONTROL V.2003 POINT "6C11 23NWW6", BEING A RIVET AND SQUARE ALUMINUM PLATE IN THE TOP OF CURB, NORTHEAST CORNER OF MARYLAND PARKWAY AND ROCHELLE AVENUE NEAR THE PC OF MARYLAND PARKWAY.

ELEVATION: 2009.29 (US SURVEY FEET)

CLARK COUNTY VERTICAL CONTROL V.2003 BASED ON NORTH AMERICAN VERTICAL DATUM OF 1988 (NAVD 88).

# CONSTRUCTION NOTES

ITEM USDCCA: UNIFORM STANDARD DRAWINGS CLARK COUNTY AREA.

CONSTRUCT "L" TYPE CURB PER USDCCA DWG. No. 216.

CONSTRUCT CONCRETE SIDEWALK PER CCAUSD DWG. No. 234.

) CONSTRUCT SIDEWALK ADA RAMP PER CCAUSD DWG. No. 235 CASE I.

(6) CONSTRUCT 2' CONCRETE VALLEY GUTTER PER DETAIL 'B' SHEET C8.01

CONSTRUCT 2.5" AC PAVING OVER 6" TYPE II OVER 4" TYPE I AGGREGATE BASE. SAWCUT EXISTING AC PAVEMENT OR CONCRETE WALK AND MATCH EXISTING GRADE/

CONSTRUCT SIDEWALK UNDERDRAIN PER CCAUSD No. 236

CONSTRUCT O" CURB FACE CONCRETE CURB PER DETAIL 'C' SHEET C8.01

CONSTRUCT CURB OPENING PER DETAIL 'D' SHEET C8.01

INSTALL MODIFIED NDOT TYPE 2A DROP INLET, SEE DETAIL "E" SHEET C8.01

SHEET C8.01, LENGTH PER PLAN.

| INSTALL RIP RAP, D50 = 4", T=8". PAD DIMENSIONS PER PLAN.

) INSTALL 5.50 LF, 4" PVC SD @ 1.0% — CONNECT AND MATCH EX. PIPE INVERT.

(18) CONSTRUCT TYPE II CONCRETE HEADWALL PER DETAIL 'G' SHEET C8.02

(19) CONSTRUCT 5' WIDE SWALE PER DETAIL "H" SHEET C8.01

CONSTRUCT 4" PVC PIPE FOR DRAINAGE UNDER SIDEWALK. LENGTH PER PLAN.

) DAYLIGHT LINE/MATCH EXISTING GRADE

(22) CONSTRUCT 8' WIDE VALLEY GUTTER PER USCCD DWG. No. 228

23) INSTALL PRECAST BUMPER BLOCK PER USCCD DWG. No. 238

TOP MILL AND REPLACE AC PAVEMENT, FULL DEPTH, EXISTING SUBBASE TO REMAIN.

(25) CONTRACTOR TO GRADE LANDSCAPE AREA TO DRAIN AS SHOWN

# SIGHT VISIBILITY ZONE LEGEND

SIGHT VISIBILITY ZONE

# SIGHT VISIBILITY ZONE NOTE:

NO WALLS, FENCES SHRUBS, UTILITY APPURTENANCES OR ANY OTHER OBJECT, OTHER THAN TRAFFIC CONTROL DEVICES, FIRE HYDRANTS, TREES, AND STREET LIGHT POLES, MAY BE CONSTRUCTED OR INSTALLED WITHIN THE SIGHT VISIBILITY ZONE UNLESS SAID OBJECT IS MAINTAINED AT LESS THAN 24 INCHES IN HEIGHT, MEASURED FROM TOP OF CURB, OR WHERE NO CURB EXISTS, A HEIGHT OF 27 INCHES MEASURED FROM THE TOP OF ADJACENT ASPHALT, GRAVEL OR PAVEMENT STREET SURFACE. THIS RESTRICTION EXTENDS ALONG THE SIGHT VISIBILITY LINE THROUGH LANDSCAPE MEDIANS.

REPLACE ALL TRAFFIC CONTROL DEVICES (SIGNS OR PAVEMENT MARKINGS), UNDER CLARK COUNTY'S JURISDICTION, THAT ARE DISTURBED, DESTROYED, MOVED OR MODIFIED BY TRENCHING ACTIVITY TO CLARK COUNTY'S SATISFACTION. ALL MATERIAL USED SHALL MEET CLARK COUNTY'S SPECIFICATIONS OR WILL BE AN APPROVED EQUIVALENT.

T IS THE CONTRACTOR'S RESPONSIBILITY TO FILE A NOTICE OF INTENT/REQUEST TO BE INCLUDED IN THE STORM WATER GENERAL PERMIT, AND SUBMIT THE ASSOCIATED STORM WATER POLLUTION PREVENTION PLAN (SWPPP) AS REQUIRED BY FEDERAL, AND MONITORED

PROPERTY OWNER IS RESPONSIBLE TO MAINTAIN THE BEST MANAGEMENT PRACTICES SUCH AS BUT NOT LIMITED TO THE REMOVAL OF ACCUMULATED SEDIMENT AND DEBRIS AND CARE

CONTRACTOR SHALL PROVIDE EROSION CONTROL IN ALL LANDSCAPE AREAS WHERE ROOF DRAINS DISCHARGE TO GRADE UNLESS OTHERWISED NOTED HEREON.

# FLOOD ZONE NOTE:

AS SHOWN BY FLOOD INSURANCE RATE MAP NO. 32003C2557F, DATED NOVEMBER 16, 2011, AN UNSHADED ZONE X, AREA DETERMINED TO BE OUTSIDE THE 0.2% ANNUAL

CEI PROJECT: DESIGN BY: TQT TQT/SS DRAWN BY: CHECKED BY: DATE: 12/21/2016 SCALE: SHEET NUMBER C4.01 SHEET 06 OF 08

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EXP. 6-30-2018

