



**ADDENDUM 2 TO INVITATION TO BID NUMBER 5131-RB**

**ROOF REPAIR AND RECOAT OF FDH AND BSL BUILDING**

**University of Nevada, Las Vegas  
Purchasing Department  
4505 Maryland Parkway  
Las Vegas, Nevada 89154-1033  
(702) 895-3521**

**Date of Addendum: May 10, 2013**

**Date of Release: April 25, 2013**

**Date and Hour of Bid Opening: May 15, 2013 @ 3:00PM Local**

---

**Questions**

1. Question: What will be the method used to check the mils on the finished product and will the mils be measured above the granules?
1. Answer: Wet mil thickness will be taken during application of the coating by a mil gauge during the spraying of the silicone coat. The dry mil thickness will be measured by the manufacturer's representative.

**Additions/Deletions**

Attached are the roof specifications for FDH and BSL Buildings as requested.

ALL OTHER TERMS, CONDITIONS AND SPECIFICATIONS OF THIS REQUEST FOR QUALIFICATIONS REMAIN THE SAME.





WELLES PUGSLEY ARCHITECTS  
 2480 e. Tompkins Avenue, Suite 222, Las Vegas, Nevada 89121  
 ph: 702.435.1150 fax: 702.435.7699  
 e-mail: wpa@wellespugsleyarchitect.com

STAMP:

REVISIONS:


PROJECT NAME:  
**WILLIAM S. BOYD  
 SCHOOL OF LAW**  
 UNIVERSITY OF NEVADA, LAS VEGAS  
 NEVADA STATE PUBLIC WORKS BOARD  
 CONTRACT NUMBER:  
 99-CTZ

PROJECT NUMBER:  
 WP-9720

SHEET TITLE:  
**ROOF PLAN  
 ROUND BUILDING  
 AND BRIDGE**

DRAWN BY:  
 SMS 11/21  
 CHECKED BY:  
 EWC  
 DP  
 DATE:  
 12/22/00

SHEET NUMBER:  
**A1.41**

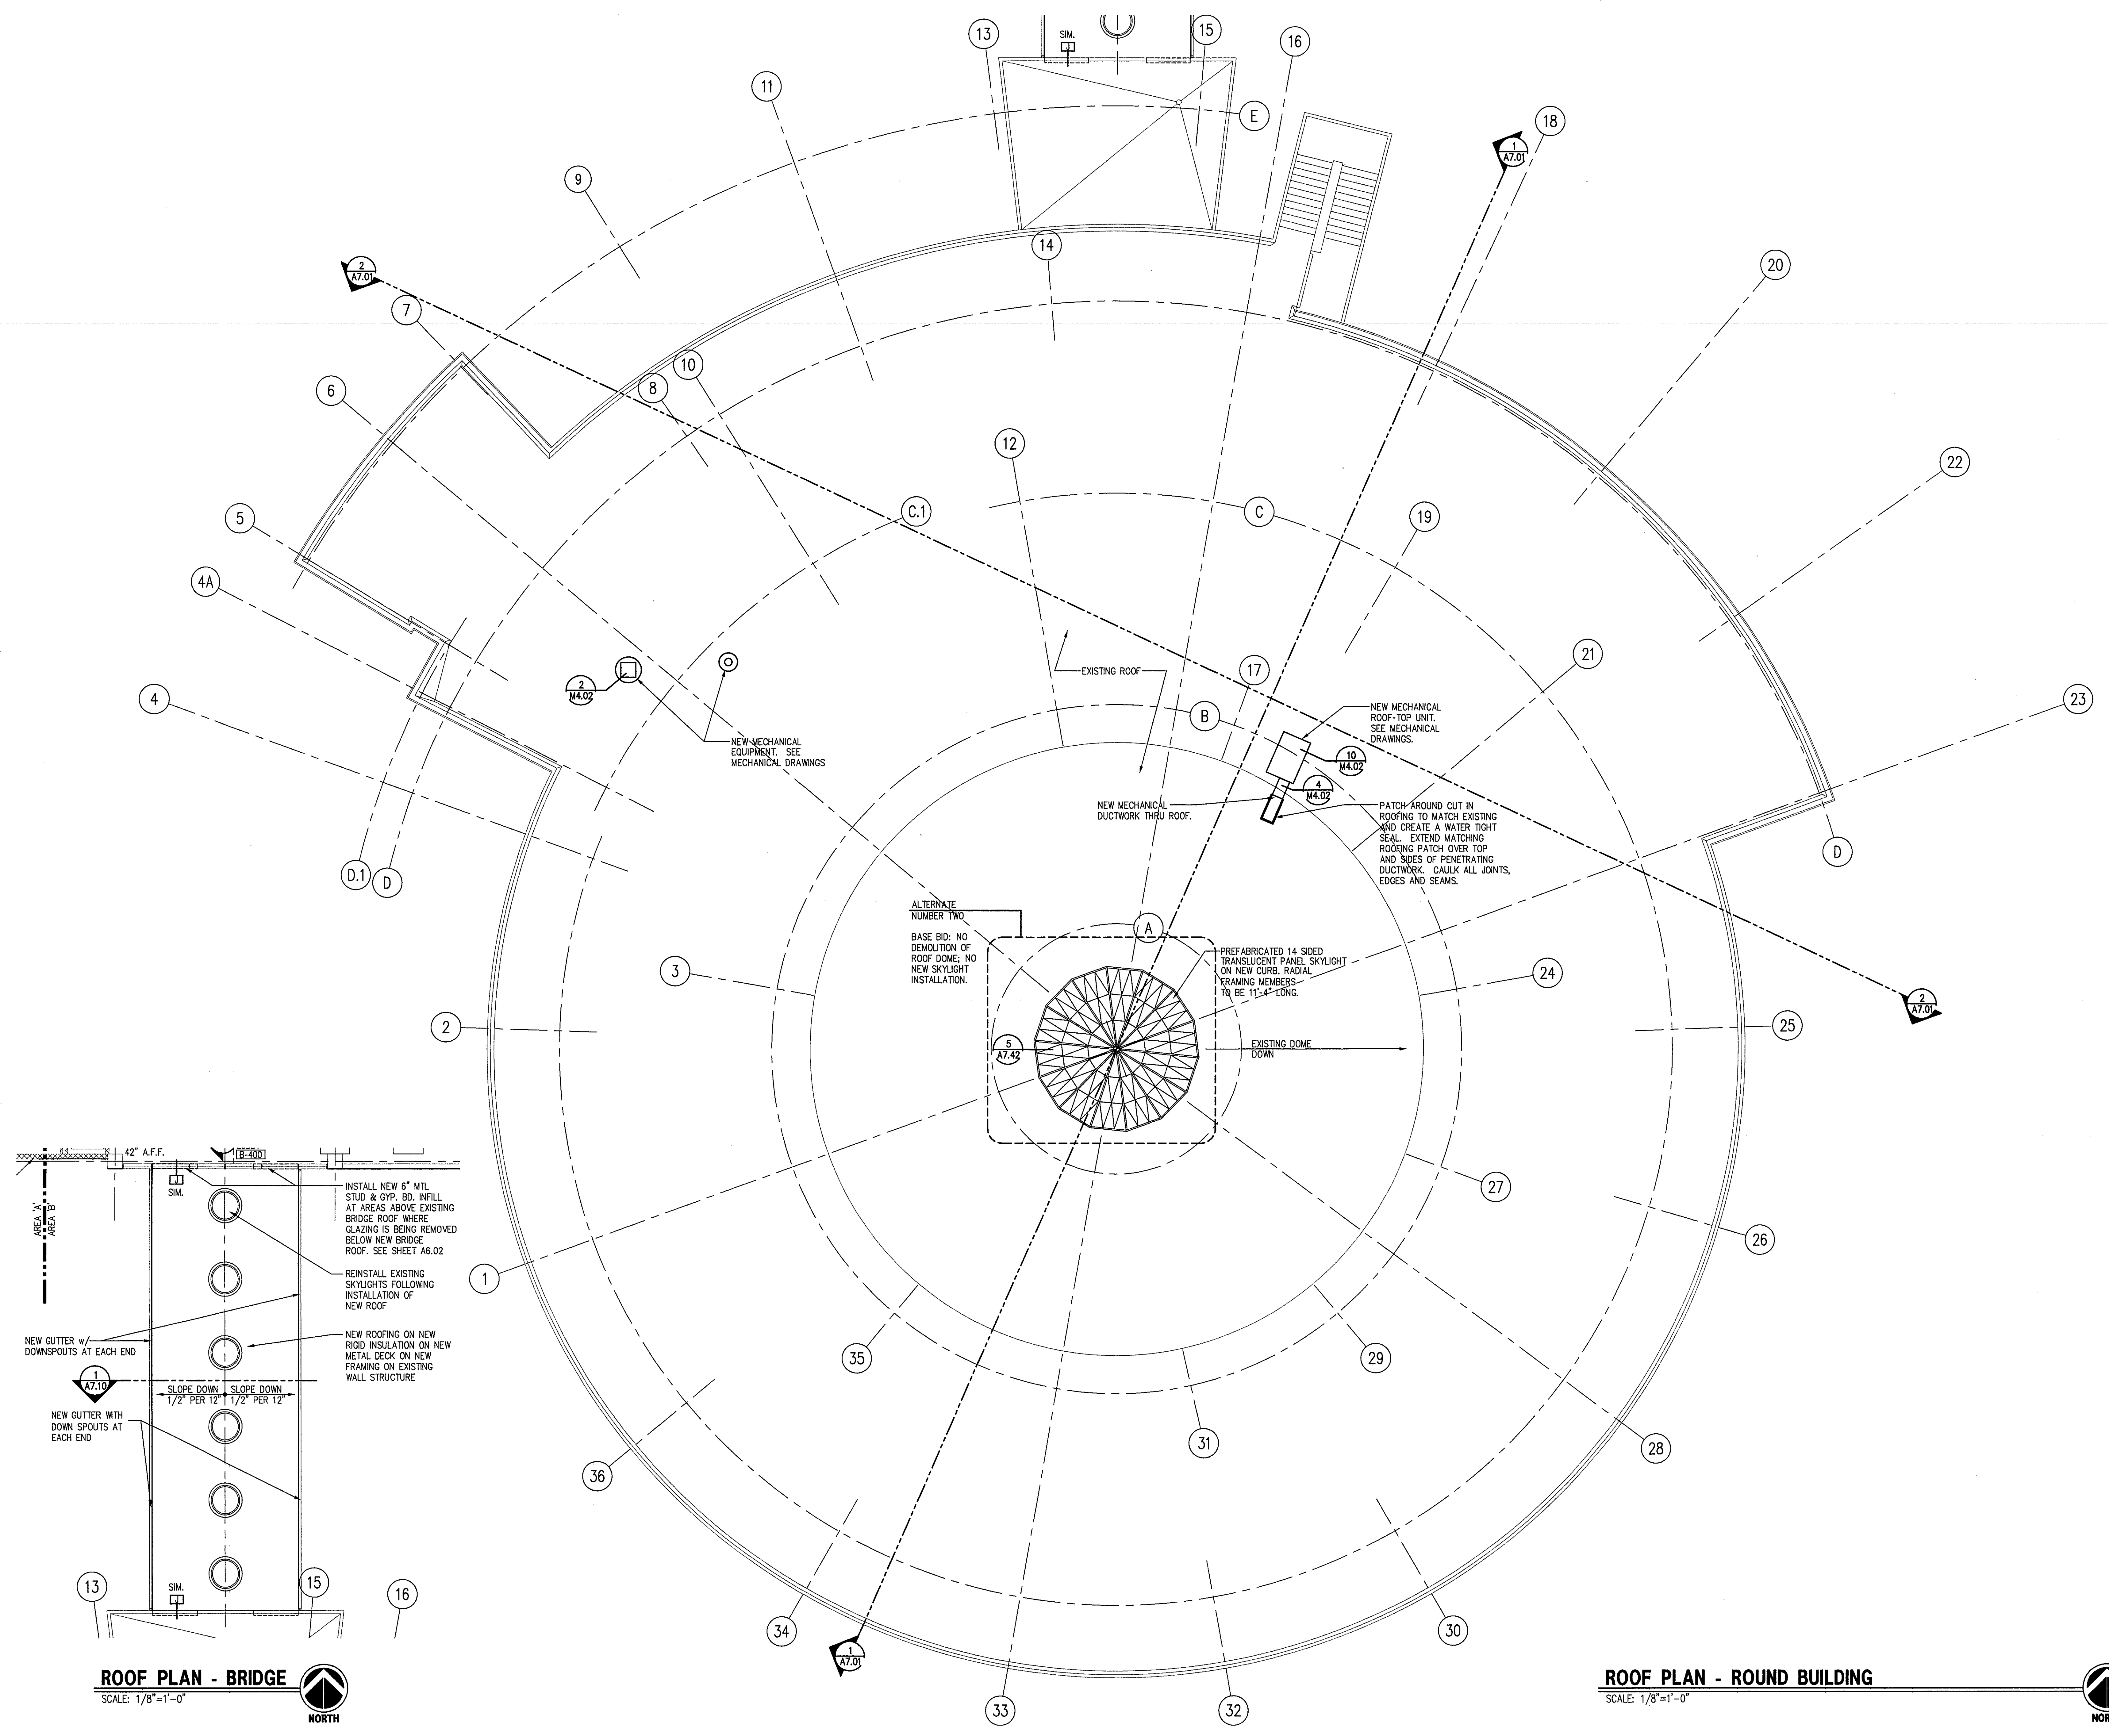

**ROOF PLAN - BRIDGE**  
 SCALE: 1/8"=1'-0"  
 NORTH

**ROOF PLAN - ROUND BUILDING**  
 SCALE: 1/8"=1'-0"  
 NORTH